
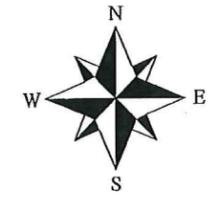



 CONTROL POINTS
 RCV
 11/12/2013


Certified by:	
REDBIRD STATE RECREATION AREA PKG AND SHELTER - SURVEY DEPARTMENT OF NATURAL RESOURCES 15298 WEST COUNTY ROAD 350 NORTH DUGGER, INDIANA 47438	
 STATE OF INDIANA DEPARTMENT OF NATURAL RESOURCES DIVISION OF ENGINEERING <small>ROOM 1020, INDIANA GOVERNMENT CENTER SOUTH 401 WEST WASHINGTON, INDIANA 46204 INDIANAPOLIS, INDIANA 46204 TEL: 317-232-4150, FAX: 317-232-1205</small>	
Restitus:	
Project Number: E100010	
Requisition Number: Requisition#	
Designer:	Drawing Date:
RV&DS	11-12-13
Drafter:	Drawing Scale:
DS	1" = 30'
DNR Approval:	
Client Approval:	
File Number: File#	
Drawing Number: C - 1	
Sheet: 2 of 8	

NEW 11/11/14 - 2208 - INDIANAPOLIS/INDIANAPOLIS/INDIANAPOLIS - REDBIRD STATE RECREATION AREA - CENTERLINE BRANCH - SURVEY

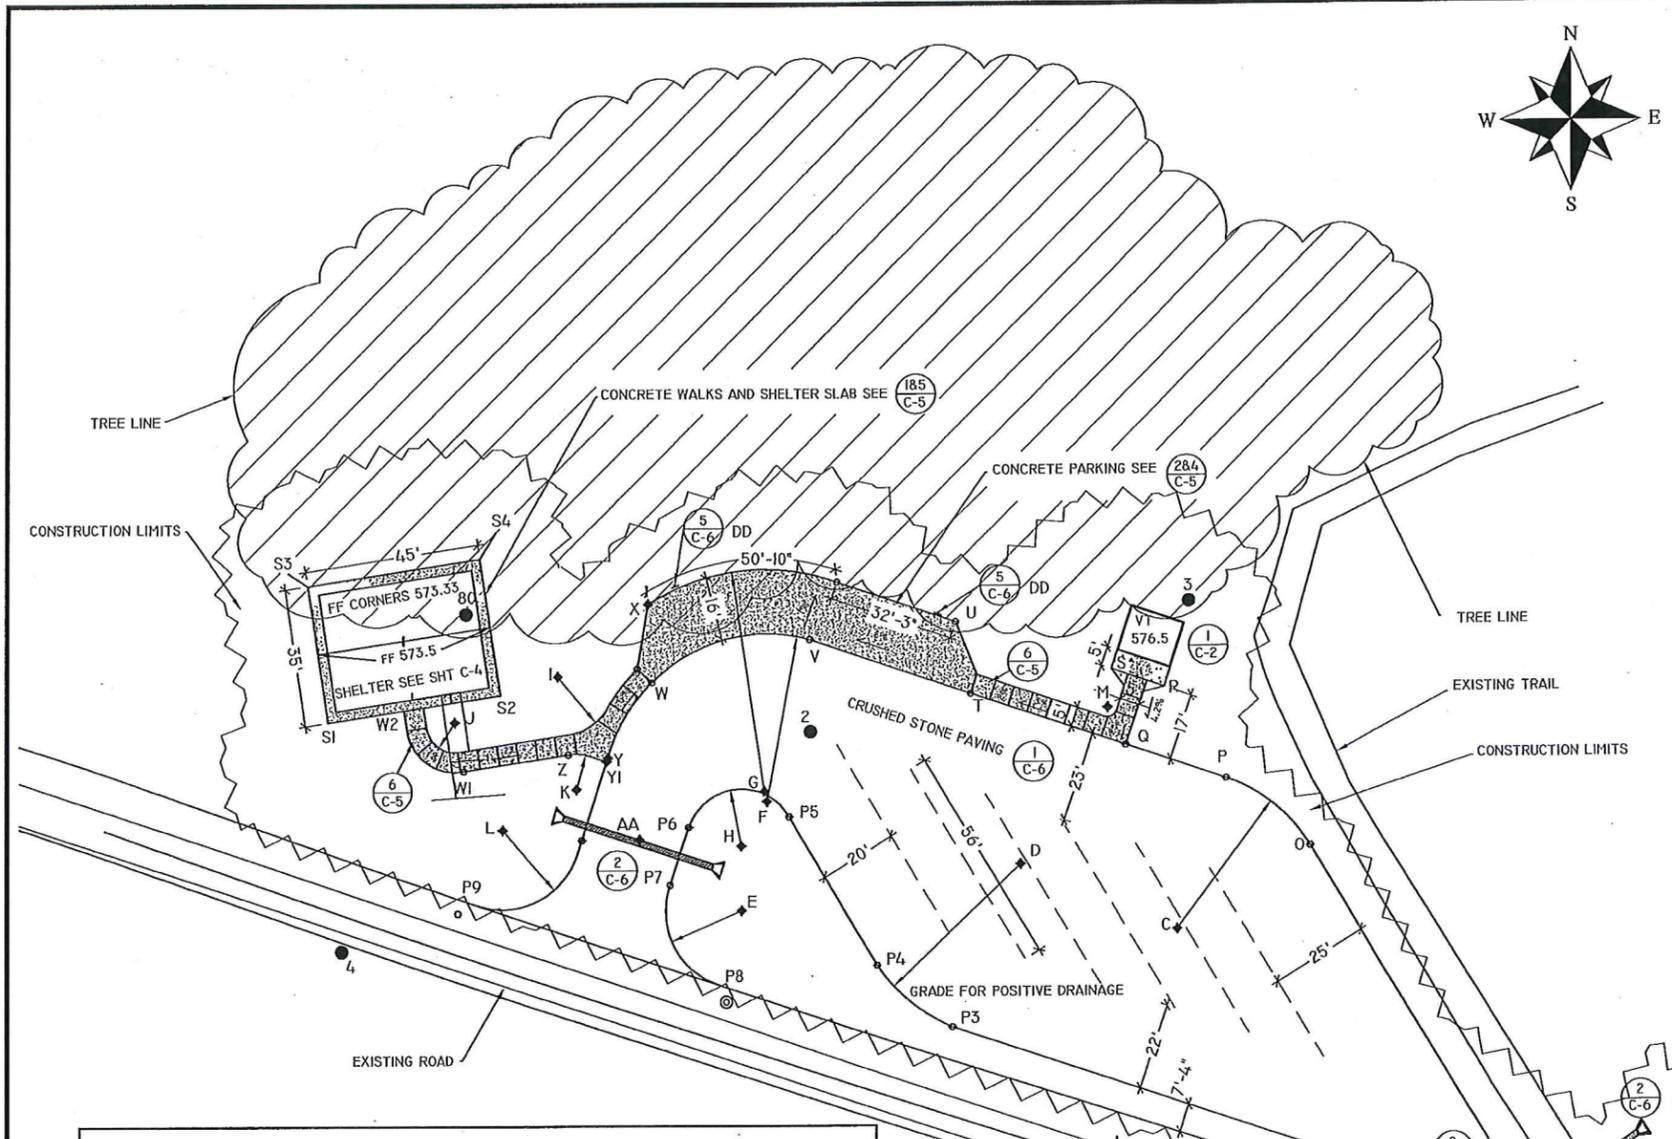

SURVEY POINT, FACILITY, AND BUILDING LOCATIONS

POINT	DESCRIPTION	NORTHING	EASTING	EX EL OR RAD
1	#5 REBAR	0.00	0.00	574.48
2	#5 REBAR	136.97	-237.23	574.37
3	#3 REBAR	169.61	-140.24	575.41
4	#3 REBAR	81.66	-357.67	575.64
50	TP #3 REBAR	15.02	-127.59	574.91
80	TP #3 REBAR	166.92	-325.61	571.43
A	RADIUS	6.81	-42.65	R = 4'-7"
B	RADIUS	22.08	-91.14	R = 3'-5"
C	RADIUS	86.71	-143.30	R = 40'
D	RADIUS	103.32	-181.31	R = 44'-6"
E	RADIUS	91.79	-255.05	R = 20'
F	RADIUS	119.37	-248.55	R = 40'-4"
G	RADIUS	121.97	-249.22	R = 56'
H	RADIUS	108.17	-255.17	R = 14'-4"
I	RADIUS	151.02	-302.13	R = 15'
J	RADIUS	139.53	-328.40	R = 7'-6"
K	RADIUS	122.52	-297.34	R = 9'
L	RADIUS	116.88	-321.42	R = 26'-4"
M	RADIUS	142.76	-161.25	R = 2'-6"
N	END CRV	4.6	-46.70	R = 4'-6"
O	BEG CRV	107.46	-109.11	
P	END CRV	124.65	-130.65	
Q	BEG WALK	133.27	-156.50	575.81
R	SE COR VT SL	147.88	-146.72	576.4
S	SW COR VT SL	152.42	-160.31	576.4
T	SW COR WALK	146.43	-195.97	574.68
U	COR PKG	164.58	-199.82	574.16
V	BEG CRV	160.26	-237.43	
W	SRT WALK	149.50	-278.33	573.01
X	NW COR PKG	169.31	-279.26	572.81
Y	END CRV	130.47	-289.45	573.88
Y1	SW COR WALK	129.57	-289.73	
Z	END CRV WALK	131.29	-299.44	
W1	BEG CRV WALK	127.20	-326.18	
W2	INT WALK SHEL	142.56	-331.52	
S1	SW COR SLAB	139.54	-361.29	573.33
S2	SE COR SLAB	146.34	-316.80	573.33
S3	NW COR SLAB	174.14	-366.58	573.33
S4	NE COR SLAB	180.94	-322.09	573.33
P1	BEG CRV	25.42	-90.20	
P2	END CRV	18.70	-91.90	
P3	BEG CRV	62.19	-200.48	
P4	END CRV	77.85	-219.88	
P5	BEG CRV	115.44	-242.76	
P6	END CRV	112.86	-268.77	
P7	BEG CRV	98.27	-273.60	
P8	END CRV	75.10	-261.20	
P9	END CRV	93.51	-323.33	
AA	NORTH EDGE PIPE	109.73	-281.37	
BB	NORTH EDGE PIPE	20.73	-71.01	
CC	NORTH EDGE PIPE	27.27	-36.10	
DD	ACCESSIBLE SIGN	AS SHOWN	AS SHOWN	DETAIL 5 C-6

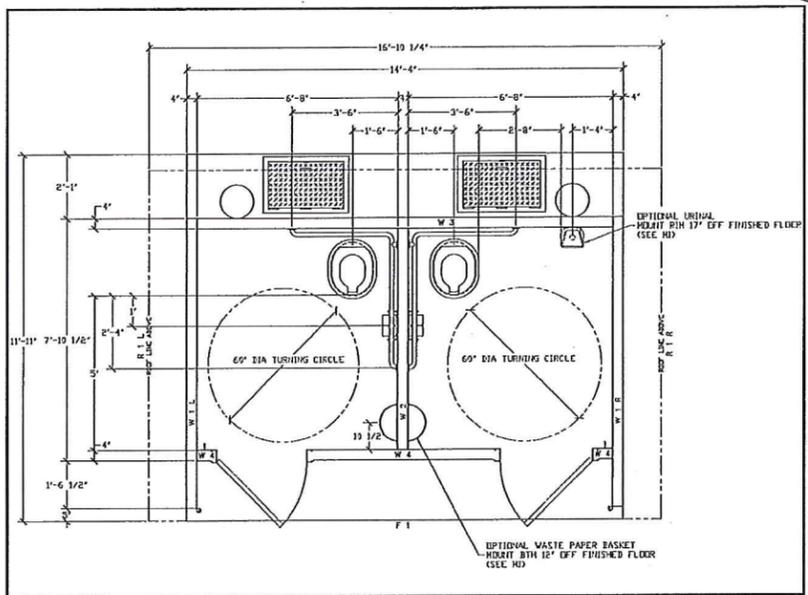

VAULT TOILET REFERENCE ONLY

NTS


1
C-2

FUTURE ROAD GRADING BY OTHERS

MOVE EXISTING CONCRETE VAULT & TOILET TO NEW LOCATION AS SHOWN ON PLAN. FILL VAULT HOLE WITH SAND AND SOIL AND COMPACT. NO ACID COAL REFUSE SHALL BE USED FOR FILL. MINE SPOIL MAY BE USED FOR FILL. PUMP AND REMOVE ALL WASTE PRIOR TO RELOCATING VAULT AND TOILET. DISPOSE OF WASTE OFF PROPERTY IN LEGAL MANNER. ANY DAMAGE OR CRACK TO MOVED BOTTOM OR TOP VAULT TOILET SHALL BE THE RESPONSIBILITY OF THE CONTRACTOR. NO NEW CRACKS SHALL BE CAUSED BY THE RELOCATION OF THE VAULT TOILET.



THE LOCATION OF UTILITIES AND STRUCTURES, BOTH SURFACE AND SUBSURFACE, ARE SHOWN ON THE PLANS FROM DATA AVAILABLE AT THE TIME OF SURVEY AND ARE NOT NECESSARILY COMPLETE OR CORRECT. THE EXACT LOCATION, AND PROTECTION OF UTILITIES AND STRUCTURES IS THE RESPONSIBILITY OF THE CONTRACTOR. DURING CONSTRUCTION THE CONTRACTOR SHALL USE DILIGENCE TO PROTECT ALL EXISTING UTILITIES AND STRUCTURES WHETHER SHOWN ON THE PLANS OR NOT. IF DAMAGE IS CAUSED, THE CONTRACTOR SHALL BE RESPONSIBLE FOR THE REPAIR AND RESTORATION OF SAME IN ACCORDANCE WITH THE DIRECTIONS OF THE ENGINEER AND FOR ANY RESULTING CONTINGENT DAMAGE.

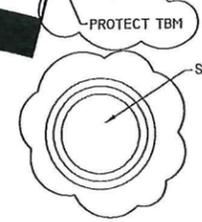

NOTES:
THIS PROJECT PLAN IS ON A MINE SPOIL AREA WITH APPROXIMATELY 2 FEET OF COVER (MINE SPOIL) OVER ACID GOB. STOP WORK AND NOTIFY OWNER IF ACID GOB IS ENCOUNTERED.

TREE LINE IS APPROXIMATE. CONTRACTOR SHALL REMOVE ALL VEGETATION ENCOUNTERED AS PER SPECIFICATIONS.


AA - 40' OF ADS DRAINAGE PIPE, SEE SPECIFICATIONS
BB - 36' OF ADS DRAINAGE PIPE, SEE SPECIFICATIONS
CC - 25' OF ADS DRAINAGE PIPE, SEE SPECIFICATIONS

TREES HAVE BEEN CUT, REMOVE DEBRIS TO THIS LOCATION -ACROSS ROAD-

REDBIRD STATE RECREATION AREA
PKG AND SHELTER - DEVELOPMENT
DEPARTMENT OF NATURAL RESOURCES
15298 WEST COUNTY ROAD 350 NORTH
DUGGER, INDIANA 47438



Project Number:	E100010
Requisition Number:	Requisition#
Designer:	DS
Drawing Date:	8-14-14
Drawn:	DS
Drawing Scale:	1" = 20'
Client Approval:	
File Number:	File#
Drawing Number:	C-2
Sheet:	3 of 8

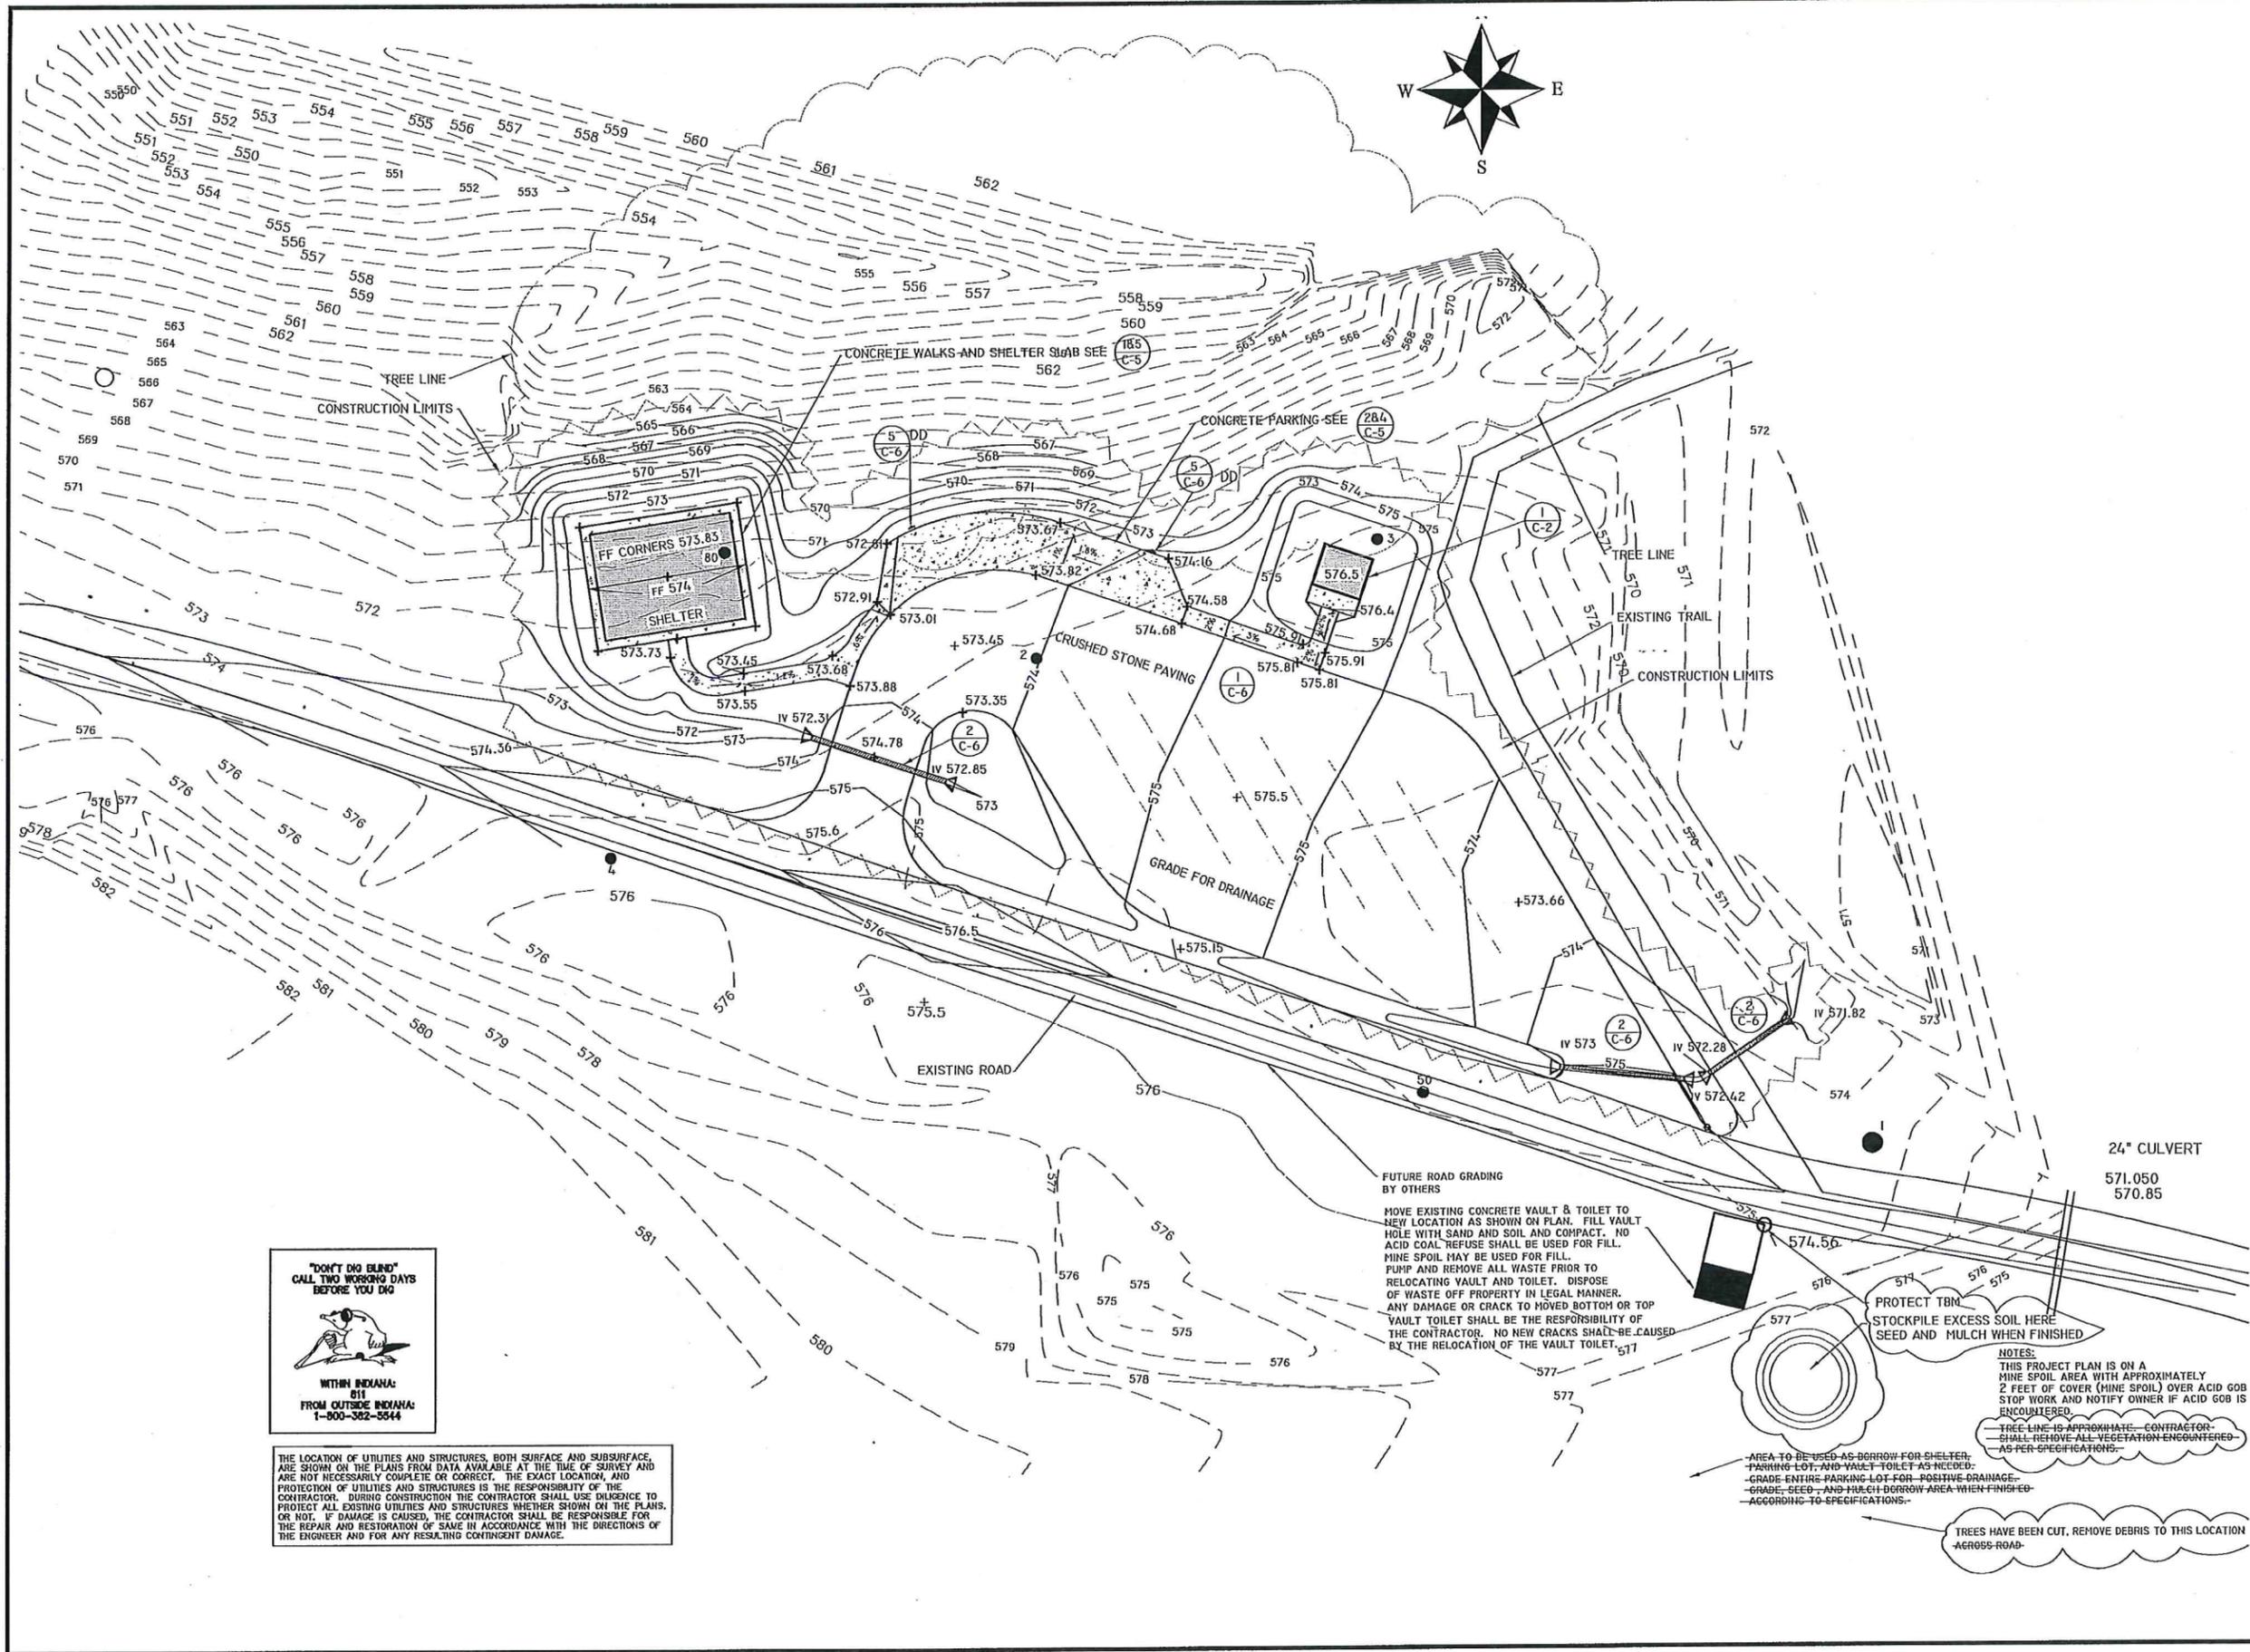

THE LOCATION OF UTILITIES AND STRUCTURES, BOTH SURFACE AND SUBSURFACE, ARE SHOWN ON THE PLANS FROM DATA AVAILABLE AT THE TIME OF SURVEY AND ARE NOT NECESSARILY COMPLETE OR CORRECT. THE EXACT LOCATION, AND PROTECTION OF UTILITIES AND STRUCTURES IS THE RESPONSIBILITY OF THE CONTRACTOR. DURING CONSTRUCTION THE CONTRACTOR SHALL USE DILIGENCE TO PROTECT ALL EXISTING UTILITIES AND STRUCTURES WHETHER SHOWN ON THE PLANS, OR NOT. IF DAMAGE IS CAUSED, THE CONTRACTOR SHALL BE RESPONSIBLE FOR THE REPAIR AND RESTORATION OF SAME IN ACCORDANCE WITH THE DIRECTIONS OF THE ENGINEER AND FOR ANY RESULTING CONTINGENT DAMAGE.

Certified by:	
REDBIRD STATE RECREATION AREA PKG AND SHELTER - GRADING DEPARTMENT OF NATURAL RESOURCES 15298 WEST COUNTY ROAD 350 NORTH DIGGER, INDIANA 47438	
 STATE OF INDIANA DEPARTMENT OF NATURAL RESOURCES DIVISION OF ENGINEERING ROOM 1029, INDIANA GOVERNMENT CENTER SOUTH 402 WEST WASHINGTON STREET INDIANAPOLIS, INDIANA 46204 TEL: 317-232-4150, FAX: 317-232-1205	
Revision:	REVISION #1 MARCH 27, 2015
Project Number:	EJ00010
Requisition Number:	Requisition#
Designer:	DS
Drawing Date:	8-14-14
Drafter:	DS
Drawing Scale:	1" = 20'
DNR Approval:	
Client Approval:	
File Number:	File#
Drawing Number:	C-3
Sheet:	4 of 8

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**Structure Erection: Installation of this structure is to be done with a competent supervisor in the construction trades. The supervisor must be capable of reading the drawings & following Cedar Forest Products' installation instructions using good construction practices and procedures. The contractor will be required to trim, cut and make adjustments of fitting for proper building erection.

**Returns: After receipt of materials, the general contractor is responsible for the condition. No merchandise can be returned without written authorization. Merchandise with return authorization must be in saleable condition. A 35% restocking fee will be charged. Merchandise to be returned must be shipped insured and freight prepaid.

**Cedar Forest Products will not be liable for any unauthorized field work purchases to replace/replace materials. Any purchases must have prior written approval from Cedar Forest Products.


THE FOLLOWING WILL BE THE RESPONSIBILITY OF OTHERS:
 1. ALL CONSTRUCTION SHALL MEET STATE & LOCAL BLDG. CODE REQS.
 2. ASSUMED SOIL BEARING CAPACITY = 5000 P.S.F. ALL FOOTINGS TO BEAR ON UNDISTURBED SOIL.
 3. CONSULT WITH A LOCAL REGISTERED STRUCTURAL ENGINEER IF SOIL BEARING CONDITIONS ARE OTHER THAN ABOVE.
 4. DESIGN, LOCATION AND CONSTRUCTION OF THE STRUCTURE'S FOUNDATION MUST BE VERIFIED BY A REGISTERED STRUCTURAL ENGINEER.
 5. DETERMINE ALL DESIGN LOADS PER LOCAL CODES.

4000 P.S.I.
 6. CONCRETE TO BE 28-DAY COMPRESSIVE STRENGTH IN 28 DAYS.
 7. REINFORCING STEEL TO BE ASTM-A-305 DEFORMED.
 8. ALL CONSTRUCTION SURVEYING AND FIELD VERIFICATION OF ALL DIMENSIONS.
 9. PROVIDE AND INSTALL ALL CONCRETE, REINFORCING STEEL, & ANCHOR BOLTS.
 10. UNLOAD ALL TRUCKS DRIVING ON THE STRUCTURE'S FOUNDATION.
 11. ERECT ON OF THE STRUCTURE.

DESIGN DATA
SNOW LOAD= 30 PSF
DEAD LOAD= 15 PSF
WIND LOAD= 25 PSF
NOTE: CUSTOMER TO VERIFY ALL STATE AND LOCAL CODES

NOT FOR CONSTRUCTION

FINAL FOOTING AND SHELTER DESIGN BY STRUCTURAL ENGINEER REGISTERED IN INDIANA

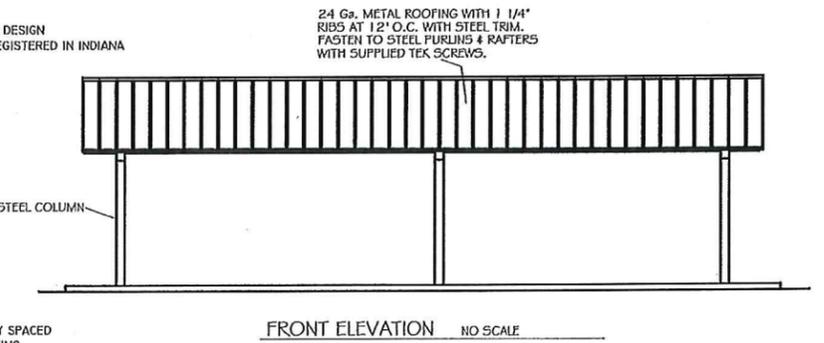


CONTRACTOR TO ADHERE TO ALL LATEST INDIANA BUILDING CODES. SEE BELOW AND SPECIFICATIONS:
 DESIGN FOR 500PSF SOIL CONDITIONS

CONTRACTOR TO ADHERE TO THE FOLLOWING AS A MINIMUM:
 COLUMNS ARE TO BE STEEL, SURFACE MOUNTED AND EQUALLY SPACED
 COLUMNS SHALL BE SURFACE MOUNTED INTO CONCRETE FOOTING WITH HOT DIPPED GALVANIZED ANCHOR BOLTS. COLUMNS SHALL REST ON STEEL BASE PLATE AND HAVE STEEL BASE PLATE COVER.
 MINIMUM LIVE LOAD 30 PSF, MINIMUM WIND LOAD BASED ON 90 MPH WIND SPEED. DESIGNED FOR SEISMIC ZONE 2A. SNOW LOAD 30 PSF.
 ROOF IS TO BE 24 GA. STEEL PANELS ASTM-A-446 HOT DIPPED GALVANIZED 12 INCH CENTERS. COLUMNS AND ROOF ARE TO BE EPOXY PRIMED 2.0 MILS. MINIMUM, THEN FINISHED WITH ENAMEL WITH POLYURETHANE ENHANCER 1.5-2.0 MILS MINIMUM.
 FOOTINGS ARE TO BE CONCRETE AND FLUSH WITH SLAB. SIZE TO BE DETERMINED BY REGISTERED STRUCTURAL ENGINEER.
 COLORS ARE: COLUMNS - TAN; ROOF - GREEN WITH WHITE UNDERSIDE.
 FINAL COLOR CHOICES WILL BE CHOSEN BY PROPERTY MANAGER

Note* SNOW, WIND, LIVE LOADS AND SEISMIC ZONE ARE LISTED ABOVE AS THE LATEST CODES AT THIS TIME. THE STRUCTURE FOR THIS PROJECT SHOULD BE DESIGNED TO THE LATEST INDIANA CODES AT THE TIME OF CONSTRUCTION.

SEE SHEET C - 5 FOR DETAILS

FOR ILLUSTRATION ONLY, FINAL FOOTING DESIGN BY REGISTERED STRUCTURAL ENGINEER FROM IN

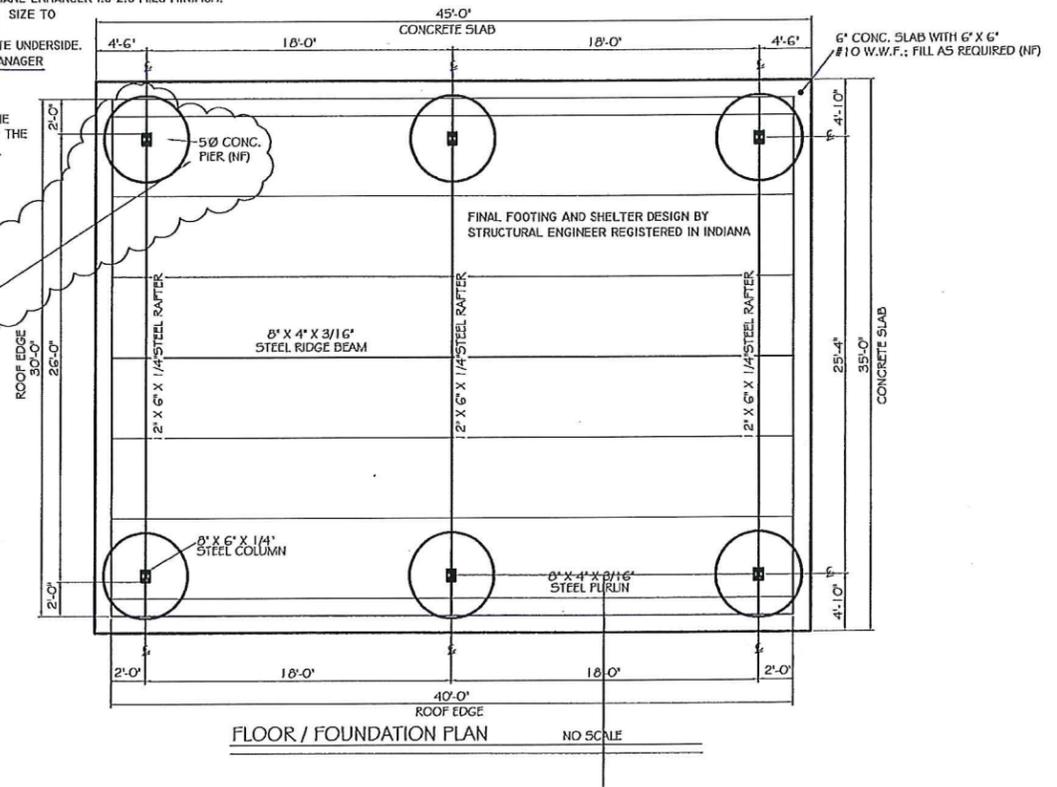

CONTRACTOR TO PROVIDE FINAL DRAWINGS APPROVED AND SIGNED BY REGISTERED INDIANA STRUCTURAL ENGINEER. SHELTER SHALL BE EQUAL TO SUGGESTED FOREST SHELTER PRODUCT SHOWN HERE.




1008 S. DIVISION - BOX 98
 POLO, ILLINOIS 61064
 (815)-946-3994
 (815)-946-2479 FAX
 WWW.CEDARFORESTPRODUCTS.COM

REVIEWED BY:	NF--DENOTES NOT FURNISHED BY CEDAR FOREST PRODUCTS
DEALER NAME:	PARK SUPPLY DIRECT
CITY/STATE:	SUGAR GROVE, IL.
SALESPERSON:	JENNIFER MENCAS


QTY - 1	ROG53040
OWNER NAME:	REDBIRD STATE RECREATION AREA
CITY/STATE/ZIP:	GREENE COUNTY, IN.

REVISION DATES	DRAWN BY/DATE/JOB#
REV:	KLY 6/24/11
REV:	PK3092
REV:	1 OF 1

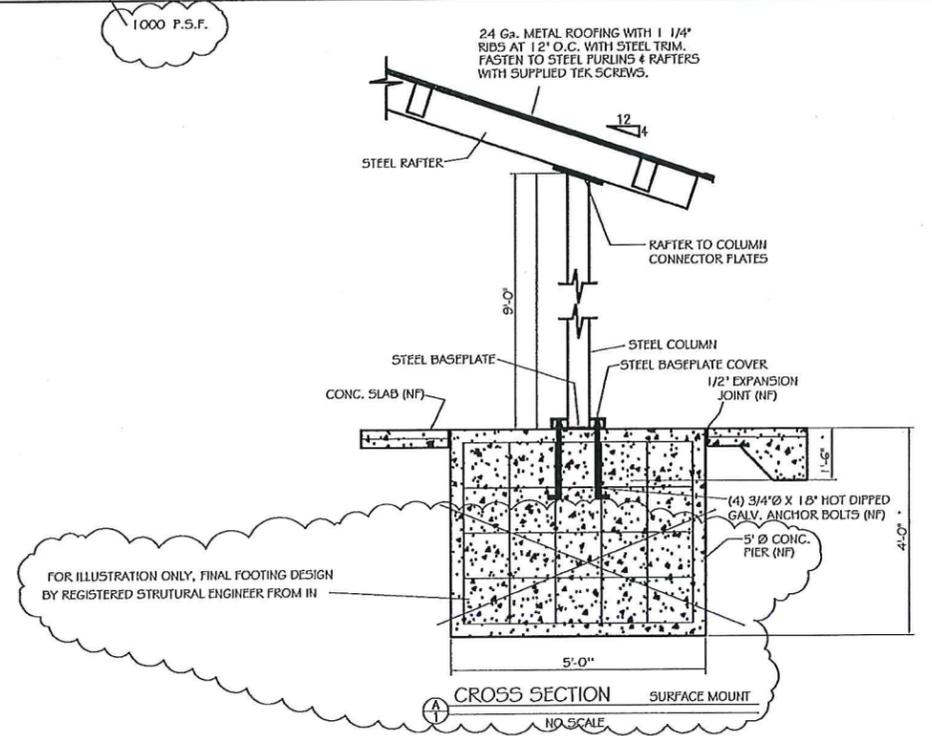

FOR ILLUSTRATION ONLY, FINAL FOOTING DESIGN BY REGISTERED STRUCTURAL ENGINEER FROM IN

* FINAL FOOTING AND SHELTER DESIGN BY STRUCTURAL ENGINEER REGISTERED IN INDIANA

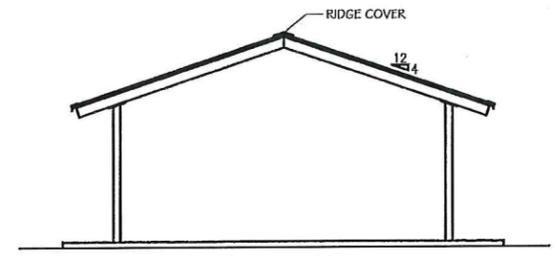

FINAL FOOTING AND SHELTER DESIGN BY STRUCTURAL ENGINEER REGISTERED IN INDIANA

Certified by:

REDBIRD STATE RECREATION AREA
 PKG AND SHELTER - SHELTER DETAILS
 DEPARTMENT OF NATURAL RESOURCES
 15298 WEST COUNTY ROAD 350 NORTH
 DUGGER, INDIANA 47438



STATE OF INDIANA
 DEPARTMENT OF NATURAL RESOURCES
 DIVISION OF ENGINEERING
 ROOM W209, INDIANA GOVERNMENT CENTER SOUTH
 402 WEST WASHINGTON STREET
 INDIANAPOLIS, INDIANA 46204
 TEL: 317-232-4150, FAX: 317-232-1205

Revision:
 REV #1 MARCH 27, 2015

Project Number: E100010
 Requisition Number: Requisition#

Designer: Drawing Date: 8-12-14
 Drafter: DS Drawing Scale: AS NOTED

DNR Approval:


Client Approval:

File Number: File#
 Drawing Number: C-4
 Sheet: 5 of 8

March 2015 - 2016: INDIANA GOVERNMENT CENTER SOUTH, ROOM W209, INDIANAPOLIS, INDIANA 46204

NOTES:

- * EXPANSION AND CONTRACTION JOINTS LOCATION, WIDTH, AND DEPTH SHOULD BE DESIGNED BY INDIANA REGISTERED STRUCTURAL ENGINEER PROVIDED BY CONTRACTOR
- * FINAL LOCATION OF SLAB BY OWNER IN THE FIELD.
- * FINAL FOOTING, SLAB, AND SHELTER DESIGN BY INDIANA REGISTERED STRUCTURAL ENGINEER.

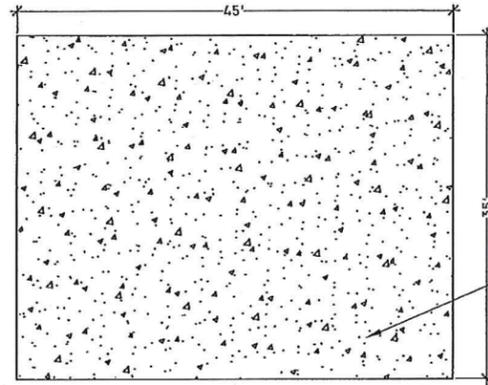


9" CLASS VI CONCRETE SLAB WITH 6X6-W2.9X W2.9 OVER 8" - #53 CRUSHED STONE OVER GEOTEX 401 FABRIC OR APPROVED EQUAL.

CONCRETE PICNIC SHELTER SLAB PLAN VIEW

1
C-5

NTS

- EXPANSION JOINTS (E) 24' OC, FULL DEPTH, 1/2" WIDE.
- CONSTRUCTION JOINTS (C) 12' OC, 3" DEEP, 1/8" WIDE IF SAWN, OTHERWISE TOOL JOINTS.

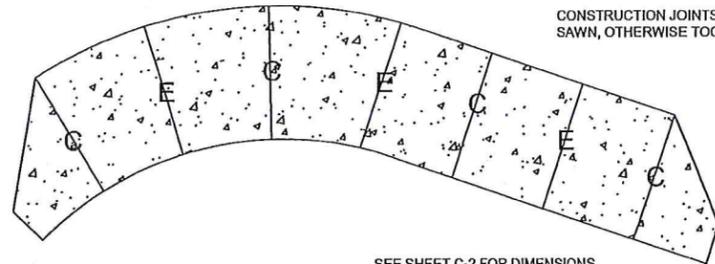


SEE SHEET C-2 FOR DIMENSIONS

CONCRETE PARKING DIMENSIONS AND JOINTS

2
C-5

NTS

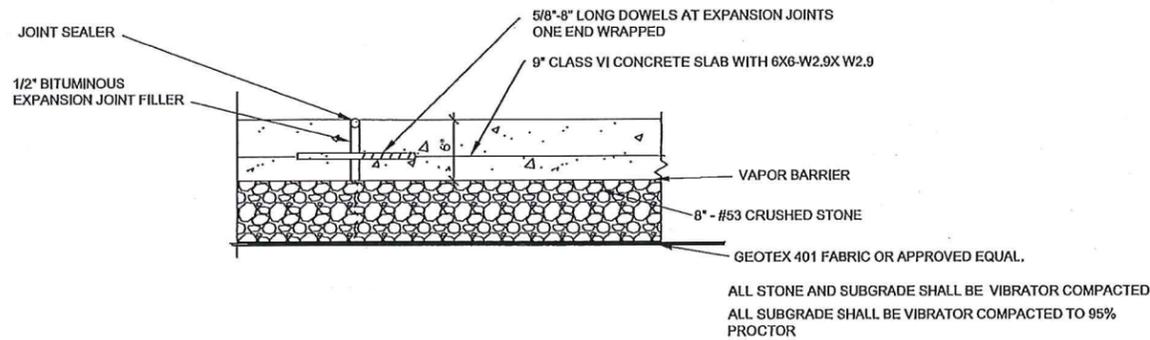


ALL STONE AND SUBGRADE SHALL BE VIBRATOR COMPACTED
ALL SUBGRADE SHALL BE VIBRATOR COMPACTED TO 95% PROCTOR

CONCRETE PICNIC SHELTER SLAB

5
C-5

NTS

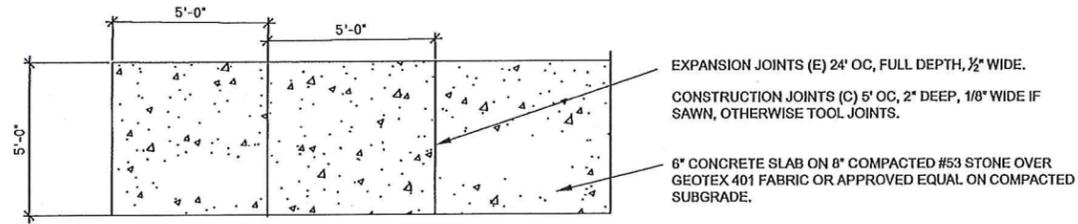


- EXPANSION JOINTS (E) 24' OC, FULL DEPTH, 1/2" WIDE.
- CONSTRUCTION JOINTS (C) 5' OC, 2" DEEP, 1/8" WIDE IF SAWN, OTHERWISE TOOL JOINTS.
- 6" CONCRETE SLAB ON 8" COMPACTED #53 STONE OVER GEOTEX 401 FABRIC OR APPROVED EQUAL ON COMPACTED SUBGRADE.

CONCRETE WALKS PLAN VIEW

3
C-5

NTS

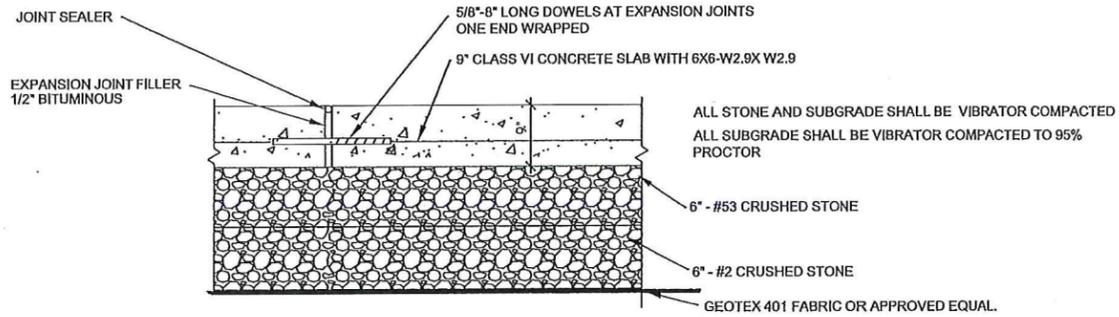


ALL STONE AND SUBGRADE SHALL BE VIBRATOR COMPACTED
ALL SUBGRADE SHALL BE VIBRATOR COMPACTED TO 95% PROCTOR

CONCRETE PARKING SECTION

4
C-5

NTS

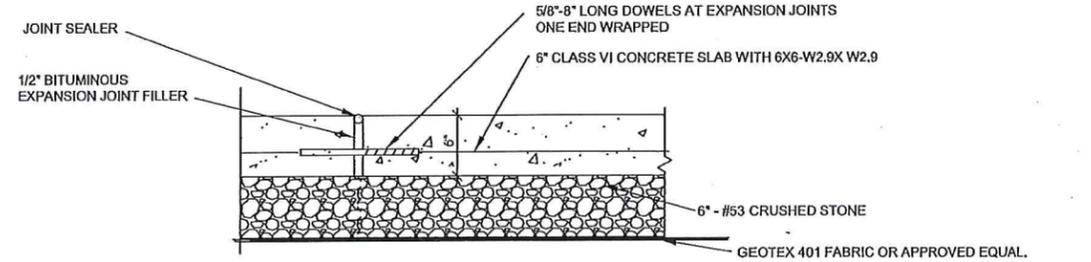

ALL STONE AND SUBGRADE SHALL BE VIBRATOR COMPACTED
ALL SUBGRADE SHALL BE VIBRATOR COMPACTED TO PROCTOR


CONCRETE WALKS AND APRON

6
C-5

NTS

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PKG AND SHELTER - DETAILS
DEPARTMENT OF NATURAL RESOURCES
15298 WEST COUNTY ROAD 350 NORTH
DUGGER, INDIANA 47438

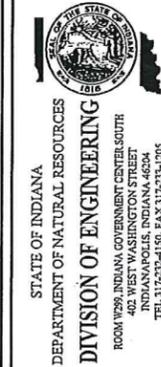

Revision:

Project Number: E100010

Requisition Number: Requisition#

Designer: DS Drawing Date: 8-23-14

Checker: DS Drawing Scale: AS NOTED

DNR Approval:




Client Approval:

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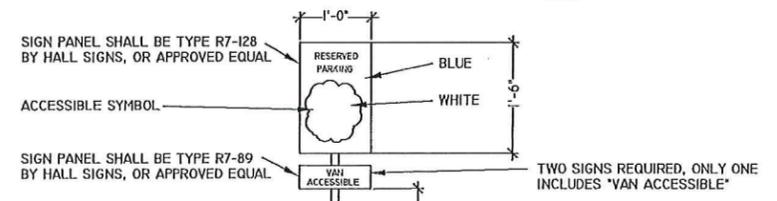
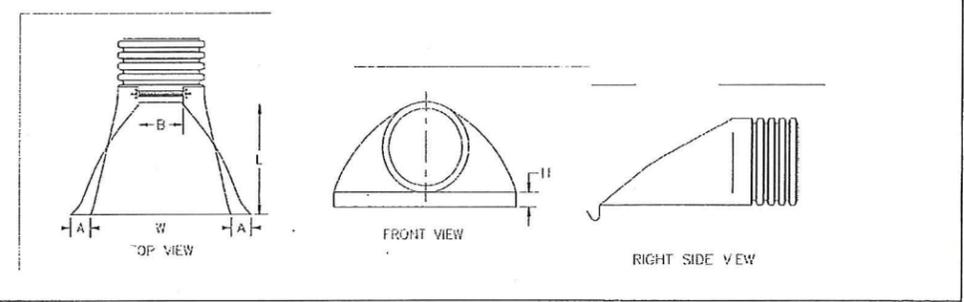
Drawing Number: C-5

Sheet: 6 of 7

10/25/2014 10:58am EXACTING AND ELECTROPHOTOGRAPHIC REPRODUCTION - HIGHER STATE BOARD APPROVED TRAIL DESIGN & PROGRAMMING, INC.

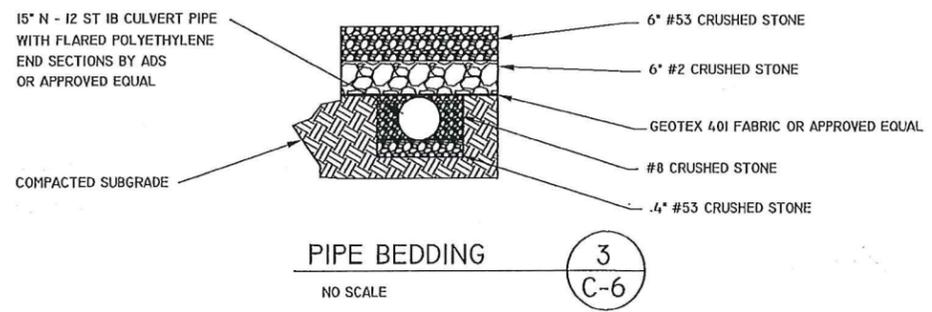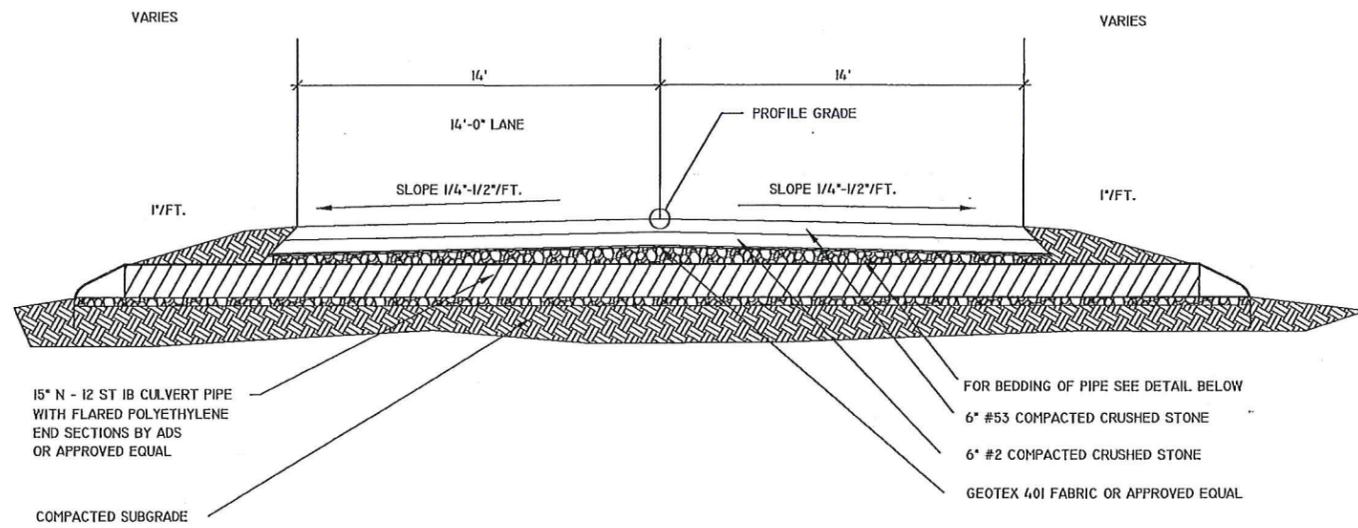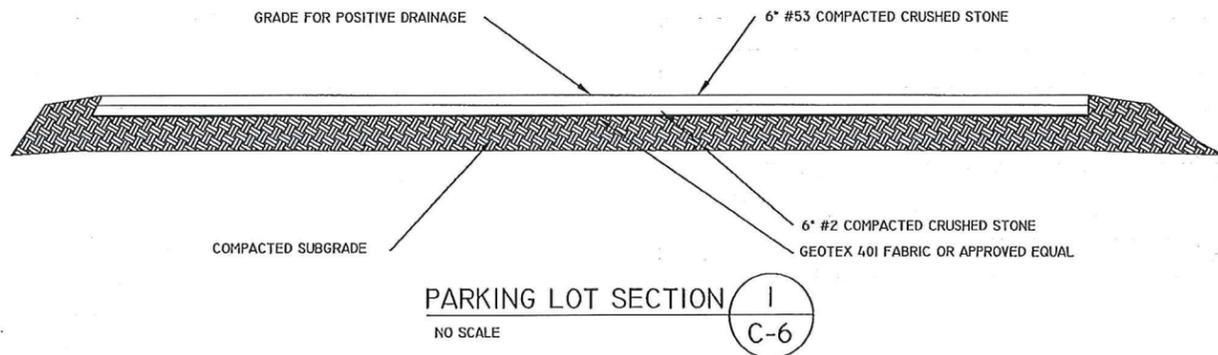

PIPE DIAMETER, in (mm)						
Diameter	12	15	18	24	30	36
In (mm)	(300)	(375)	(450)	(600)	(750)	(900)
A	6.5	6.5	7.5	7.5	7.5	7.5
In (mm)	(165)	(165)	(191)	(191)	(191)	(191)
B (max)	10.0	10.0	15.0	18.0	22.0	25.0
In (mm)	(254)	(254)	(381)	(475)	(559)	(635)
H	6.5	6.5	6.5	6.5	8.6	8.6
In (mm)	(165)	(165)	(165)	(165)	(218)	(218)
L	25.0	25.0	32.0	36.0	58.0	58.0
In (mm)	(635)	(635)	(813)	(914)	(1473)	(1473)
W	29.0	29.0	35.0	45.0	63.0	63.0
In (mm)	(737)	(737)	(889)	(1143)	(1600)	(1600)



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REDBIRD STATE RECREATION AREA
 PKG AND SHELTER - DRAINAGE DETAILS
 DEPARTMENT OF NATURAL RESOURCES
 15298 WEST COUNTY ROAD 350 NORTH
 DUGGER, INDIANA 47438




STATE OF INDIANA
 DEPARTMENT OF NATURAL RESOURCES
DIVISION OF ENGINEERING
 ROOM 9209 INDIANA GOVERNMENT CENTER SOUTH
 402 WEST WASHINGTON STREET
 INDIANAPOLIS, INDIANA 46204
 TEL 317-232-1150, FAX 317-232-1295

Revisions:



Project Number: E100010
 Requisition Number: Requisition#
 Designer: DS Drawing Date: 8-23-14
 Drafter: DS Drawing Scale: AS NOTED
 DNR Approval:

Client Approval:

File Number: File#
 Drawing Number: C-6
 Sheet: 7 of 8

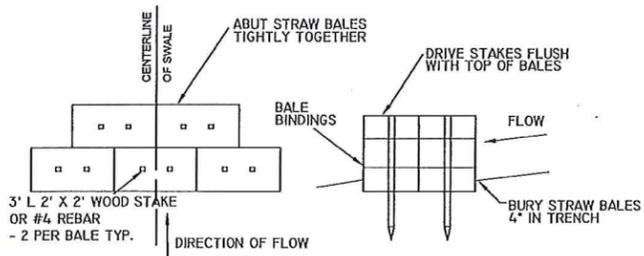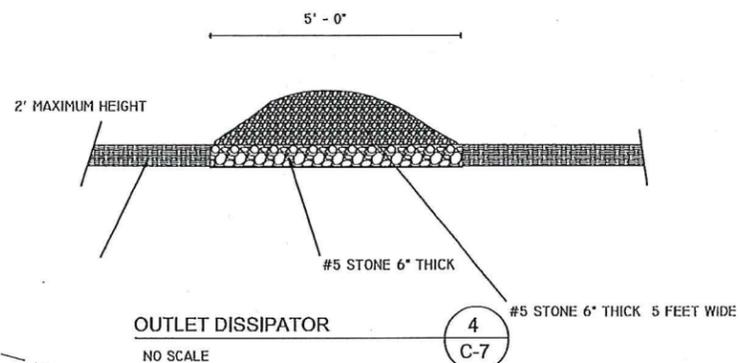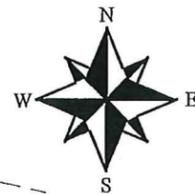

- INSTALLATION:**
1. INSTALL BALES WITH BINDINGS AROUND SIDES, NOT TOP TO BOTTOM, TO PREVENT DETERIORATION.
 2. DRIVE STAKES AT ANGLES TOWARDS PREVIOUSLY LAID BALES TO DRIVE THE BALES TOGETHER.
 3. WEDGE STRAW INTO ANY GAPS TO PREVENT WATER FROM FLOWING DIRECTLY THRU THE DAM.
 4. BACKFILL AND COMPACT EARTH AGAINST OUTSIDE OF BALES.
 5. INSTALL BALES ACROSS FULL WIDTH OF SWALE, USE AS MANY BALES AS NEEDED TO PREVENT THE FLOW FROM BYPASSING THE DAM.
 6. INSTALL STRAW BALE DAMS AT A MAXIMUM OF 100' I.O.C. ALONG SWALE LENGTH. INSTALL BALES WITH BINDINGS AROUND SIDES, NOT TOP TO BOTTOM, TO PREVENT DETERIORATION.

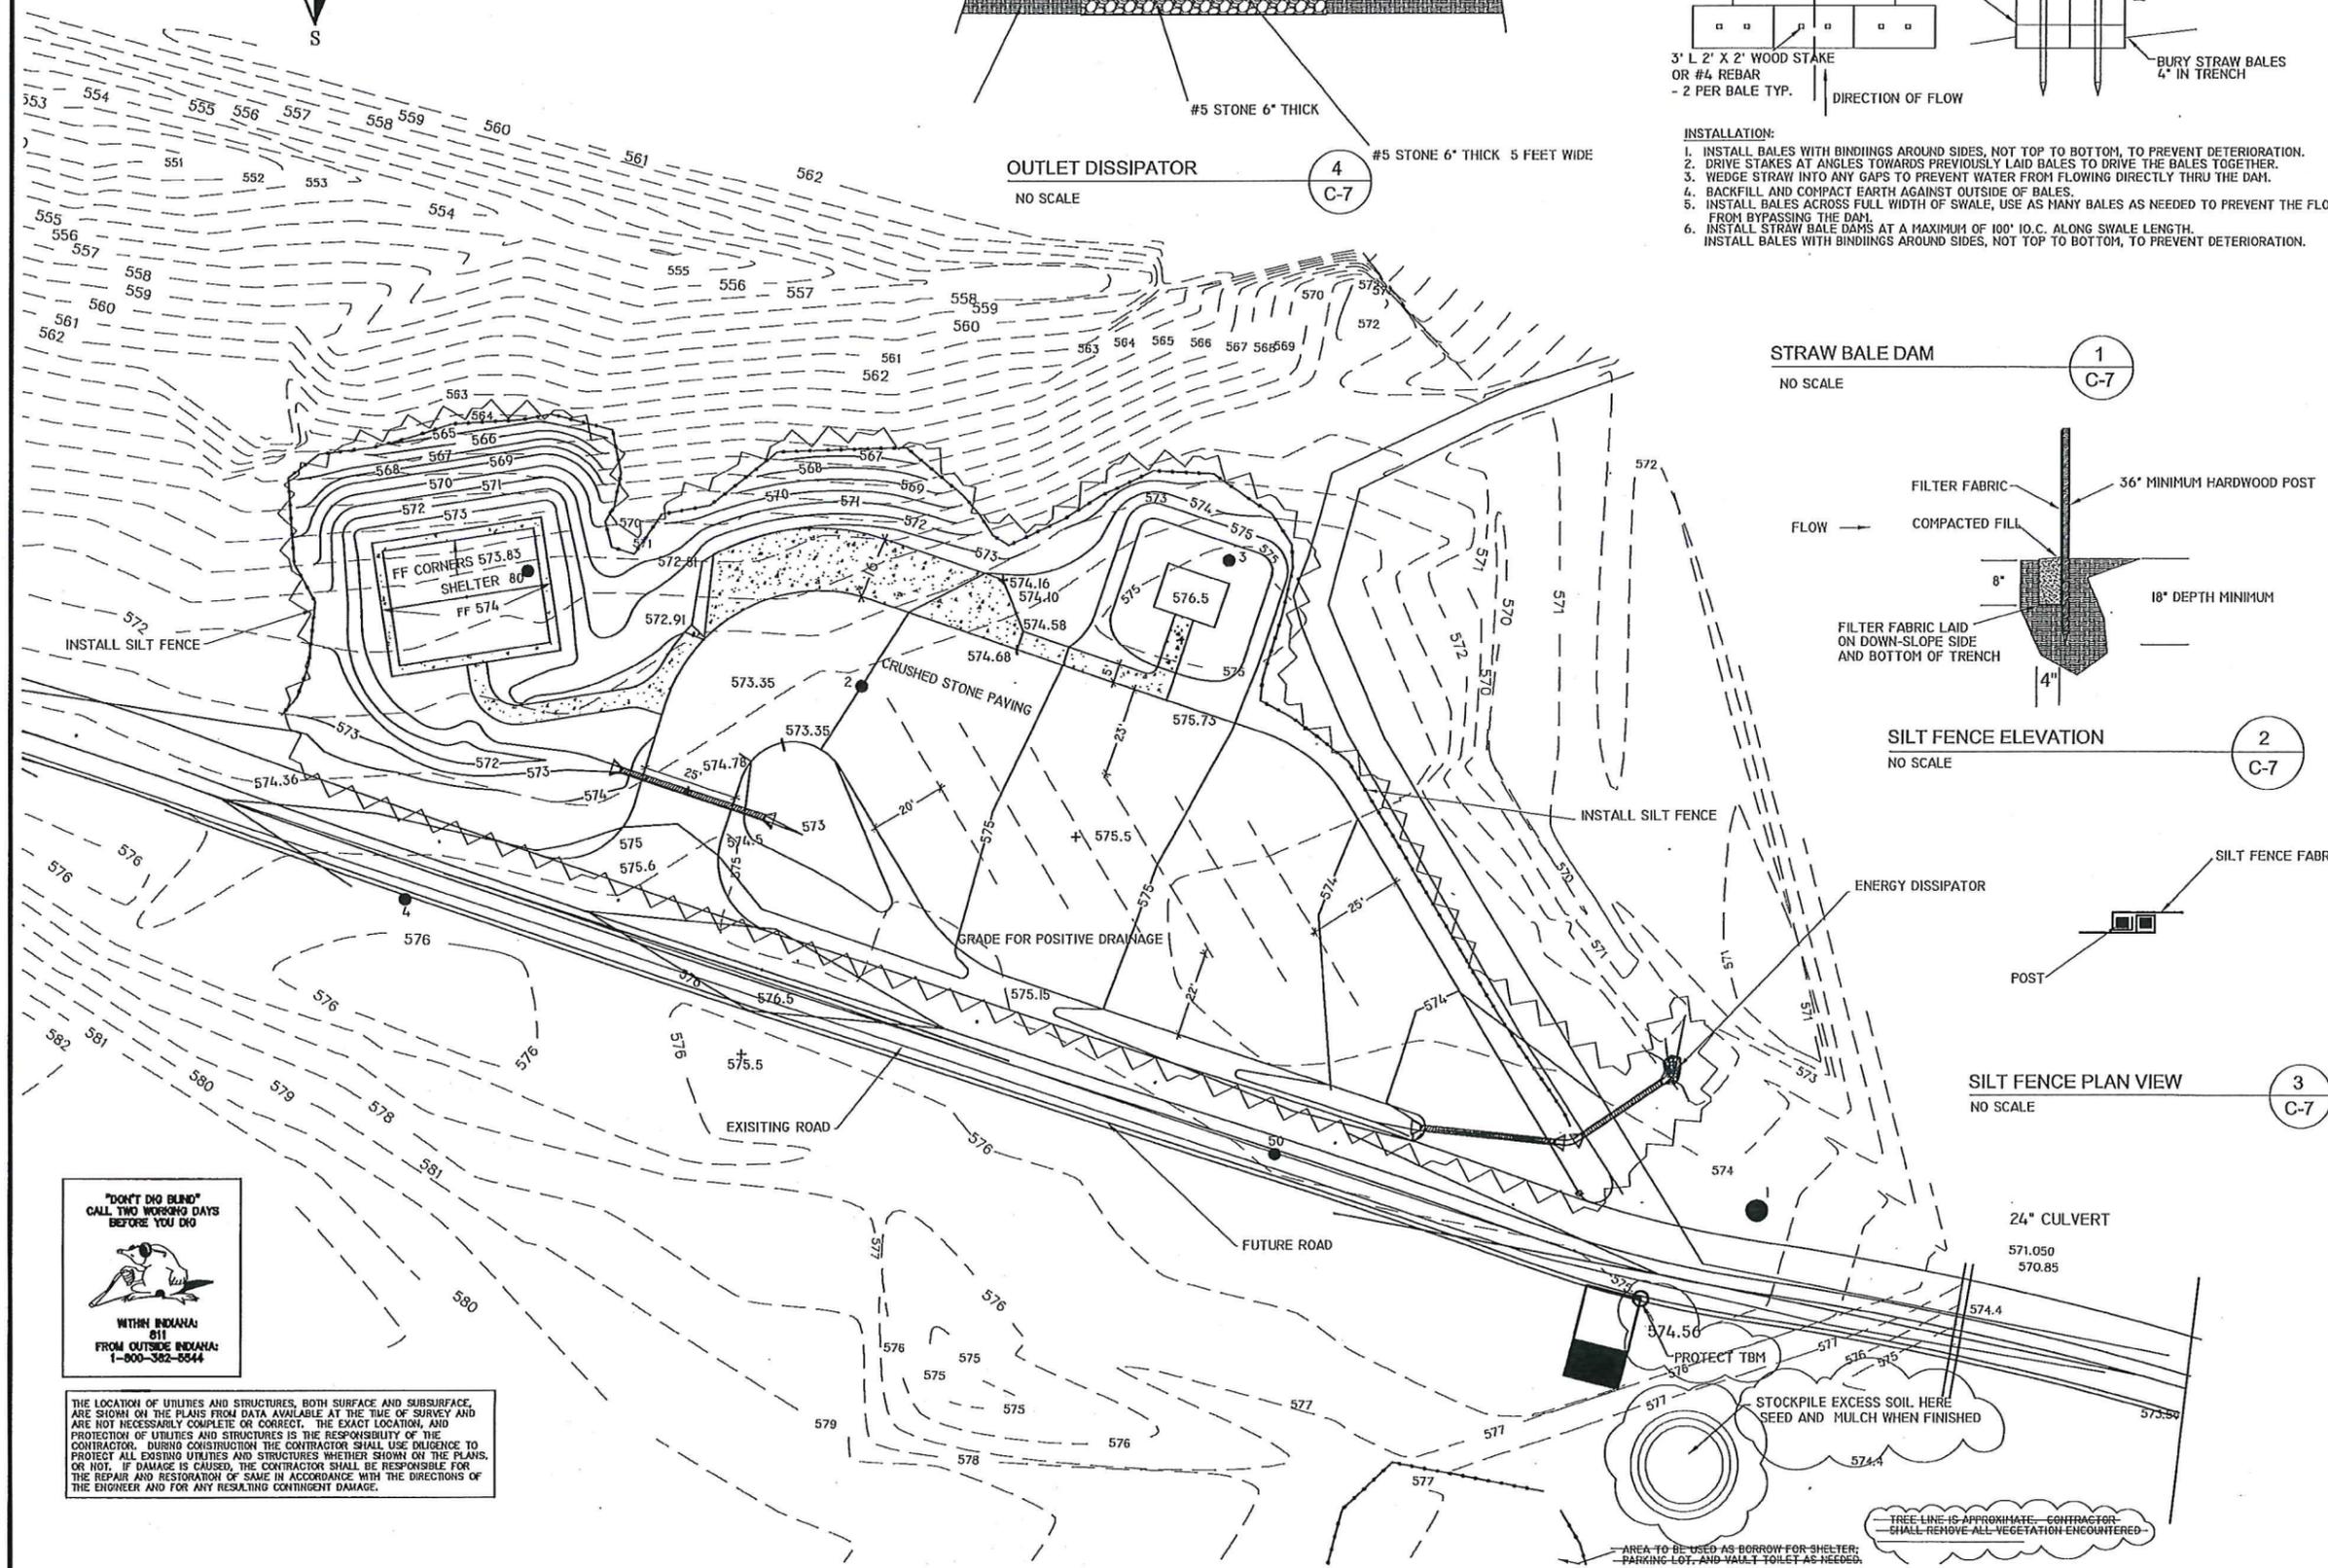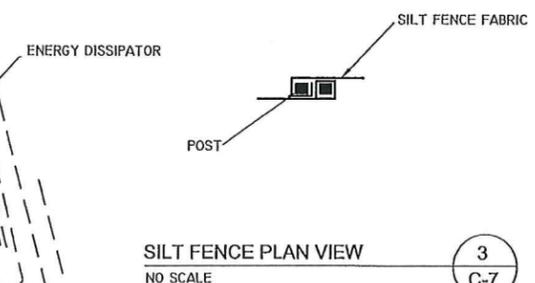

"DON'T DO BIRD"
CALL TWO WORKING DAYS
BEFORE YOU DO

WITH INDIANA:
811
FROM OUTSIDE INDIANA:
1-800-382-5544

THE LOCATION OF UTILITIES AND STRUCTURES, BOTH SURFACE AND SUBSURFACE, ARE SHOWN ON THE PLANS FROM DATA AVAILABLE AT THE TIME OF SURVEY AND ARE NOT NECESSARILY COMPLETE OR CORRECT. THE EXACT LOCATION, AND PROTECTION OF UTILITIES AND STRUCTURES IS THE RESPONSIBILITY OF THE CONTRACTOR. DURING CONSTRUCTION THE CONTRACTOR SHALL USE DILIGENCE TO PROTECT ALL EXISTING UTILITIES AND STRUCTURES WHETHER SHOWN ON THE PLANS, OR NOT. IF DAMAGE IS CAUSED, THE CONTRACTOR SHALL BE RESPONSIBLE FOR THE REPAIR AND RESTORATION OF SAME IN ACCORDANCE WITH THE DIRECTIONS OF THE ENGINEER AND FOR ANY RESULTING CONTINGENT DAMAGE.

AREA TO BE USED AS BORROW FOR SHELTER; PARKING LOT, AND VAULT TOILET AS NEEDED.

FREE LINE IS APPROXIMATE. CONTRACTOR SHALL REMOVE ALL VEGETATION ENCOUNTERED.

REDBIRD STATE RECREATION AREA
PKG AND SHELTER - EROSION CONTROL
DEPARTMENT OF NATURAL RESOURCES
15298 WEST COUNTY ROAD 350 NORTH
DUGGER, INDIANA 47438

STATE OF INDIANA
DEPARTMENT OF NATURAL RESOURCES
DIVISION OF ENGINEERING
ROOM 1929, INDIANA GOVERNMENT CENTER SOUTH
400 WASHINGTON STREET
INDIANAPOLIS, INDIANA 46204
TEL: 317-232-1454, FAX: 317-232-1385

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